



**ABBREVIATIONS**

(ADDITIONAL ABBREVIATIONS MAY BE LOCATED ON SPECIFIC SHEETS)

AB/ASB	AGGREGATE BASE/SUBBASE	FL	FLOWLINE	QCV	QUICK COUPLER VALVE
AC	ASPHALT CONCRETE	FP	FENCE POST	R	RADIUS
BC	BOTTOM OF CURB	FS	FINISHED SURFACE	RCP	REINFORCED CONCRETE PIPE
BLDG	BUILDING	FTF	FACE TO FACE	ROW	RIGHT OF WAY
BM	BENCH MARK	GB	GRADE BREAK	RT	RIGHT
BMP	BEST MANAGEMENT PRACTICES	GR	GRATE	RW	RETAINING WALL
BW	BOTTOM OF WALK	GV	GAS VALVE	SC	SAW CUT
BPU	BACKFLOW PREVENTER UNIT	HVCAB	HIGH VOLTAGE CABINET	SG	SUBGRADE/TOP OF SUBGRADE
CIP	CAST IN PLACE	ICC	IRRIGATION CONTROL CABINET	SD	STORM DRAIN
CJ	COLD JOINT	INV	INVERT	SDE	STORM DRAIN EASEMENT
CLF	CHAIN LINK	IRCV	IRRIGATION REMOTE CONTROL VALVE	SDMH	STORM DRAIN MANHOLE
CL	CENTERLINE	IRR	IRRIGATION SPRINKLER HEADS	SHR	SHRUB
CLR	CLEAR	JB	JUNCTION BOX	SL	SLEEVE
CO	CLEANOUT	LOW	LIMIT OF WORK	SP	SPOT ELEVATIONS
COF	CITY OF FREMONT FIBER OPTICS	LV ELE	LOW VOLTAGE ELECTRICAL FOR REMOTE CONTROL VALVES	SPP	SPECIES
CONC	CONCRETE	LT	LEFT	SS	SANITARY SEWER
CONF	CONFORM	MAX	MAXIMUM	SSE	SANITARY SEWER EASEMENT
COTG	CLEANOUT TO GRADE	MIN	MINIMUM	SSMH	SANITARY SEWER MANHOLE
CP	CONCRETE PAD	MON	MONUMENT	SW	SIDEWALK
DG	DECOMPOSED GRANITE	MOW	MOWSTRIP	TB	TOP OF SLOPE
DJ	DEEP JOINT	(N)	NEW ON CENTER	TC	TOP OF CURB
DI	DRAINAGE INLET	NTS	NOT TO SCALE	TEMP	TEMPORARY
DWY	DRIVEWAY	OC	ON CENTER	TG	TOP OF GRATE
DWTC	DRIVEWAY TOP OF CURB	PA	PLANTING AREA	T	TREE
(E)	EXISTING	PB/HH	PULLBOX / HAND HOLE	TRF	TRAFFIC
EP	EDGE OF PAVEMENT	PCC	PORTLAND CEMENT CONCRETE	TS	TOE OF SLOPE
EPB	ELECTRICAL PULL BOX	PLTR	PLANTER	TVB	TELEVISION/CABLE BOX
EQ	EQUAL	PP	POWER POLE	TV	TOP OF WALL
E.S.	EQUAL SPACING	PT	POINT	TYP	TYPICAL
EX	EXISTING	PVC	POLYVINYL CHLORIDE	VLT	VAULT
FCE	FENCE			WM	WATER METER
FG	FINISHED GRADE			WV	WATER VALVE

**PROJECT NOTES**

- POST AND NETTING DESIGN IS TO BE DESIGN BUILD BY THE AWARDED CONTRACTOR.
- THE CONTRACTOR SHALL VISIT THE SITE PRIOR TO BID SUBMITTAL TO DETERMINE THE EXACT EXTENT AND DEPTH OF SITE DEMOLITION REQUIRED AND VERIFY COMPLIANCE WITH DRAWINGS. THE OWNER SHALL BE NOTIFIED IMMEDIATELY OF ANY DISCREPANCIES.
- THE CONTRACTOR SHALL PERFORM ALL CLEARING, DEMOLITION, REMOVAL OF OBSTRUCTIONS AND SITE PREPARATIONS NECESSARY FOR THE PROPER EXECUTION OF ALL WORK CONTAINED IN THE CONTRACT DOCUMENTS.
- THE CONTRACTOR SHALL VERIFY THE LOCATIONS OF ALL EXISTING UTILITIES, STRUCTURES AND SERVICES BEFORE COMMENCING WORK. THE LOCATIONS OF UTILITIES, STRUCTURES AND SERVICES SHOWN IN THE CONTRACT DOCUMENTS SHALL BE DEEMED TO BE APPROXIMATIONS ONLY. ALL DISCREPANCIES BETWEEN WHAT IS SHOWN AND THE ACTUAL FIELD CONDITIONS SHALL BE REPORTED TO THE CITY REPRESENTATIVE. THE CONTRACTOR SHALL CONTACT UNDERGROUND SERVICE ALERT (USA) AT (800) 227-2600 PRIOR TO ANY DEMOLITION OR EXCAVATION. UPON COMPLETION OF USA MARKING OPERATIONS, CONTRACTOR SHALL RECORD ALL UTILITY MARKINGS ON A SEPARATE SET OF DRAWINGS. THIS SET SHALL BE KEPT ON-SITE FOR REFERENCE FOR DURATION OF CONTRACT. NOTIFY THE CITY REPRESENTATIVE IMMEDIATELY SHOULD CONFLICTS ARISE AND REDIRECT WORK TO AVOID DELAY.
- CONTRACTOR SHALL VERIFY LOCATION OF ALL EXISTING UTILITIES AND PROVIDE THE REQUIRED COORDINATION FOR THEIR TEMPORARY DISCONNECTION, PROTECTION, REMOVAL AND/OR STORAGE AS MAY BE REQUIRED DURING CONSTRUCTION. CONTRACTOR SHALL COORDINATE WITH THE CITY TO DETERMINE WHETHER TEMPORARY SERVICES ARE NECESSARY.
- ALL EXISTING ITEMS ARE TO REMAIN UNLESS OTHERWISE NOTED. THE CONTRACTOR SHALL BE RESPONSIBLE FOR REPAIRING OR REPLACING, AT CONTRACTOR'S EXPENSE, ANY EXISTING ITEM DAMAGED OR DESTROYED BY CONSTRUCTION OPERATIONS. CONTRACTOR SHALL ALSO BE RESPONSIBLE FOR REPAIRING OR REPLACING ANY AND ALL DAMAGES TO ADJACENT PROPERTIES. THE DAMAGED ITEMS SHALL BE RESTORED TO AN "AS-WAS" OR BETTER CONDITION OR REPLACED PER THE DISCRETION OF THE CITY'S REPRESENTATIVE.
- ALL (E) TREES, LAWN AND OTHER PLANTINGS LOCATED OUTSIDE THE LIMIT OF WORK LINE SHALL BE PRESERVED TO REMAIN AND BE PROTECTED.
- THE CONTRACTOR IS TO PROTECT DRAINAGE SYSTEM FROM DEBRIS, INCLUDING SOIL, ROCK MATERIAL, AND TRASH FROM ENTERING THE PIPE DURING CONSTRUCTION. CONTRACTOR SHALL AVOID PLACING CONSTRUCTION VEHICLES OVER INSTALLED DRAINAGE TRENCHES TO PREVENT CRUSHING OF PIPE.
- THE CONTRACTOR SHALL VERIFY THE LOCATIONS OF ALL EXISTING IRRIGATION BEFORE COMMENCING WORK. THE LOCATIONS OF IRRIGATION SYSTEM SHOWN IN THE CONTRACT DOCUMENTS SHALL BE DEEMED TO BE DIAGRAMATIC OR APPROXIMATIONS ONLY. ALL DISCREPANCIES BETWEEN WHAT IS SHOWN AND THE ACTUAL FIELD CONDITIONS SHALL BE REPORTED TO THE CITY. THE CONTRACTOR SHALL RECORD THESE DISCREPANCIES ON THE RECORD DRAWINGS.
- CONTRACTOR SHALL VERIFY LOCATION OF ALL EXISTING IRRIGATION AND PROVIDE THE REQUIRED COORDINATION FOR THEIR TEMPORARY DISCONNECTION, PROTECTION, SALVAGE, REMOVAL AND/OR STORAGE AS MAY BE REQUIRED DURING CONSTRUCTION. CONTRACTOR SHALL COORDINATE WITH THE CITY AND PROVIDE TEMPORARY IRRIGATION TO ADJACENT PLANTING AREAS IMPACTED BY CONSTRUCTION.
- CONTRACTOR SHALL BE RESPONSIBLE FOR PROTECTION AND REPLACEMENT OF ALL IRRIGATION CONTROL WIRING IMPACTED BY CONSTRUCTION. EXISTING AND PROPOSED IRRIGATION SHALL BE FULLY FUNCTIONAL PRIOR TO COMMENCEMENT OF PLANT ESTABLISHMENT PERIOD. CONTRACTOR SHALL BE RESPONSIBLE FOR IRRIGATION OF EXISTING PLANT MATERIAL DURING CONSTRUCTION.
- ALL DIMENSIONS SHALL BE VERIFIED IN FIELD AND CHALKED, STRING LINED OR FLAGGED BY THE CONTRACTOR PRIOR TO CONSTRUCTION. ANY MINOR ADJUSTMENTS MADE TO ACHIEVE OVERALL DESIGN LAYOUT SHALL BE ACCEPTED BY THE CITY PRIOR TO CONSTRUCTION.
- THE INTERFACE OF ALL PROPOSED IMPROVEMENTS TO EXISTING SITE SHALL CONFORM AND BE SMOOTH AND UNIFORM.
- ALL REINFORCING AND FORMS SHALL BE SECURED IN PLACE AND ACCEPTED BY CITY REPRESENTATIVE PRIOR TO PLACING ANY CONCRETE.
- CONCRETE FINISHES SHALL BE AS NOTED PER DETAILS AND SPECIFICATIONS.
- ALL FENCES AND GATES SHOWN ON PLAN ARE GRAPHIC REPRESENTATIONS; REFER TO DETAILS AND SPECIFICATIONS FOR PRECISE LOCATION AND/OR PLACEMENT.
- ALL WORK SHALL BE PERFORMED BY PERSONS FAMILIAR AND SKILLED WITH IRRIGATION WORK UNDER THE SUPERVISION OF A QUALIFIED PLANTING FOREMAN.
- ALL EXISTING PLANT MATERIALS ARE TO BE PROTECTED DURING CONSTRUCTION. PLANTS DAMAGED BY CONSTRUCTION SHALL BE REPLACED AT THE CONTRACTOR'S EXPENSE.
- FOR ALL LANDSCAPE DETAILS, SEE CONSTRUCTION DETAILS.
- SYMBOL SHOWN FOR EXISTING TREES TO REMAIN OUTSIDE LIMITS OF WORK FOR REFERENCE ONLY. IT DOES NOT REFLECT TRUE CANOPY OR TRUNK SIZE.
- CONTRACTOR SHALL PROTECT AND MAINTAIN ALL PLANT MATERIAL FROM TIME OF DELIVERY TO TIME OF FINAL ACCEPTANCE. OWNER SHALL NOT BE RESPONSIBLE FOR LOSSES DUE TO VANDALISM, THEFT OR SEVERE WEATHER.

**STAGING AND ACCESS NOTES**

- CONTRACTOR SHALL PROPOSE AND SUBMIT STAGING PLANS TO LANDSCAPE ARCHITECT FOR APPROVAL 10 WORKING DAYS PRIOR TO CONSTRUCTION. A SUGGESTED STAGING AREA IS SHOWN WITHIN THE PARKING LOT OF STEVENSON BOULEVARD ADJACENT TO FIELDS 9 AND 10.
- STAGING AREA SHALL BE USED FOR STORAGE OF ALL CONTRACTOR EQUIPMENT AND MATERIALS.
- PRIOR TO VEHICULAR EQUIPMENT ACCESS INTO THE SITE, THE CONTRACTOR MAY NEED TO PROTECT THE EXISTING SURFACES FROM DAMAGE. PROTECTIVE SHEETING OR PLATING TO PROTECT SURFACES SHALL BE PAID FOR AND CONSIDERED INCLUDED IN ALL THE VARIOUS BID ITEMS OR WORK.
- CONTRACTOR SHALL MAINTAIN INGRESS AND EGRESS AND CIRCULATION IN THE PARKING LOTS AND PLAY AREAS AT ALL TIME DURING CONSTRUCTION.
- CONTRACTOR SHALL MAINTAIN MAIN PEDESTRIAN PATHWAY CIRCULATION AT ALL TIMES DURING CONSTRUCTION. ANY BLOCKAGES OR DETOURS SHALL BE REQUESTED IN WRITING OR PROPOSED ON PLAN. CONTRACTOR SHALL PROVIDE ADEQUATE SIGNAGE REDIRECTING PEDESTRIAN CIRCULATION.

**GENERAL DEMOLITION NOTES**

- CONTRACTOR SHALL INSTALL TEMPORARY CONSTRUCTION FENCING AT STAGING AREA PRIOR TO BEGINNING OF WORK.
- CONFIRM THE EXISTING IRRIGATION SYSTEM IS IN WORKING ORDER PRIOR TO THE COMMENCEMENT OF DEMOLITION. CONTRACTOR SHALL BE RESPONSIBLE FOR FIELD VERIFICATION OF THE ENTIRE SYSTEM IMPACTED BY CONSTRUCTION AND MAKE THE NECESSARY ADJUSTMENTS PRIOR TO DEMOLITION WORK.
- UNLESS NOTED, ALL UTILITY BOXES, POLES AND FOOTINGS TO REMAIN, SHALL BE PROTECTED.
- UTILITY BOXES AND DRAIN INLETS TO BE ADJUSTED AS NEEDED TO MEET NEW GRADES ARE IDENTIFIED IN THE PLANS.
- VERIFY IN FIELD THE LOCATION AND FUNCTIONALITY OF EXISTING CATCH BASINS OR DRAIN INLETS. NOTIFY CITY'S LANDSCAPE ARCHITECT IF THE LOCATION IS NOT SHOWN ON DRAWINGS OR IF CATCH BASINS ARE IN POOR CONDITION.
- ALL EXISTING TURF, TREES, LANDSCAPE AND IRRIGATION TO BE PRESERVED IN PLACE, UNLESS OTHERWISE NOTED. ANY DAMAGE TO THE AFOREMENTIONED UTILITIES, OR OTHER CITY PROPERTY SHALL BE REPLACED IN KIND TO THE SATISFACTION OF THE CITY'S LANDSCAPE ARCHITECT.
- REFER TO ARTICLE 16 AND SECTION 01 50 50 "CONSTRUCTION AND DEMOLITION DEBRIS MANAGEMENT" OF THE PROJECT SPECIFICATIONS FOR REQUIRED CONSTRUCTION WASTE MANAGEMENT PRACTICES.
- REMOVE EXISTING MOWBAND OR CONCRETE PAVING TO NEAREST EXISTING SCORE JOINT, UNLESS OTHERWISE SPECIFIED ON PLAN. WHERE DISCREPANCIES ARISE, CONTACT LANDSCAPE ARCHITECT FOR RESOLUTION.

**LAYOUT AND GRADING NOTES**

- COORDINATES AND DIMENSIONS PROVIDED FOR CONCRETE WORK ARE FOR INSIDE FACE OF CURB AND CENTER OF POST UNLESS OTHERWISE NOTED.
- COORDINATE ALL CONSTRUCTION ELEMENTS PRIOR TO INSTALLATION. VERIFY CRITICAL DIMENSIONS, REFERENCE, AND CONSTRUCTION CONDITIONS PRIOR TO INITIATING WORK.
- PROPOSED PAVING SURFACES SHALL MEET EXISTING PAVED SURFACES WITH A SMOOTH TRANSITION. LOW SPOTS WHICH HOLD STANDING WATER SHALL NOT BE PERMITTED AND WILL RESULT IN REMOVAL AND REPLACEMENT OF WORK (INCLUDING CONCRETE) TO ELIMINATE LOW SPOTS AT NO COST TO THE CITY.
- CONTRACTOR SHALL RELOCATE AND RECONNECT IRRIGATION LATERALS, MAINLINES, AND VALVES, AND OTHER UTILITIES ENCOUNTERED DURING EXCAVATION AND GRADING. CONTRACTOR SHALL LAY OUT PROPOSED ROUTES FOR REVIEW AND APPROVAL BY PROJECT LANDSCAPE ARCHITECT PRIOR TO INSTALLATION. ALL REVISED IRRIGATION TO ACCOMMODATE PROJECT REQUIREMENTS SHALL PROVIDE HEAD-TO-HEAD COVERAGE EVEN IF EXISTING CONDITIONS DID NOT HAVE HEAD-TO-HEAD COVERAGE. ALL IRRIGATION MATERIALS AND INSTALLATION SHALL BE PER CITY OF FREMONT'S LANDSCAPE STANDARD DETAILS OR PARK STANDARD DETAILS FOUND ON THE CITY'S WEBSITE, WWW.FREMONT.GOV. TRENCHING THROUGH EXISTING TREE ROOTS NOT ALLOWED.

FOR CITY COUNCIL



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DRAWING:					
<b>L0.2</b>					
SHEET 2 OF 13					
NOTE: VERIFY SCALE. BAR IS ONE INCH ON ORIGINAL DRAWING. ADJUST SCALES ACCORDINGLY IF BAR IS NOT ONE INCH. 0  -----  1"					
APPROVED - SENIOR LANDSCAPE ARCHITECT:  DATE: 07/27/2018 RECOMMENDED - PROJECT MANAGER:  DATE: 07/27/2018 COMMUNITY SERVICES DEPARTMENT LANDSCAPE ARCHITECTURE DIVISION NOTES AND LEGEND FIELDS 9 AND 10 FENCE EXTENSION					
LICENSED LANDSCAPE ARCHITECT # 3509 ROGER RAVENSTAD No. 3509 07/27/2018 LICENSED LANDSCAPE ARCHITECT # 4 H. VIRGINIJA STATE OF					
DATE:	07/27/2018	DATE:	07/27/2018	DATE:	07/27/2018
NO.	1	DATE:	07/27/2018	BY:	APPD
REVISION:		DATE:		BY:	

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PLOT DATE: Jul 27, 2018 - 9:07am



- EXISTING UTILITY NOTES**
1. AT LEAST TWO WORKING DAYS PRIOR TO CONSTRUCTION, THE CONTRACTOR SHALL CALL THE UNDERGROUND SERVICE ALERT FOR UTILITY LOCATIONS. PHONE: 1-800-227-2600.
  2. FOR UNDERGROUND UTILITIES THAT CANNOT BE VERIFIED BY USA, SUCH AS IRRIGATION COORDINATE WITH THE CITY'S MAINTENANCE DIVISION FOR IRRIGATION IDENTIFICATION, PARKS MAINTENANCE, PH. 510-979-5700, ATTENTION FRANK NAVA.

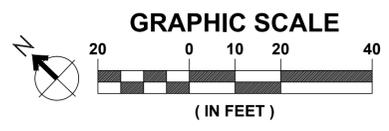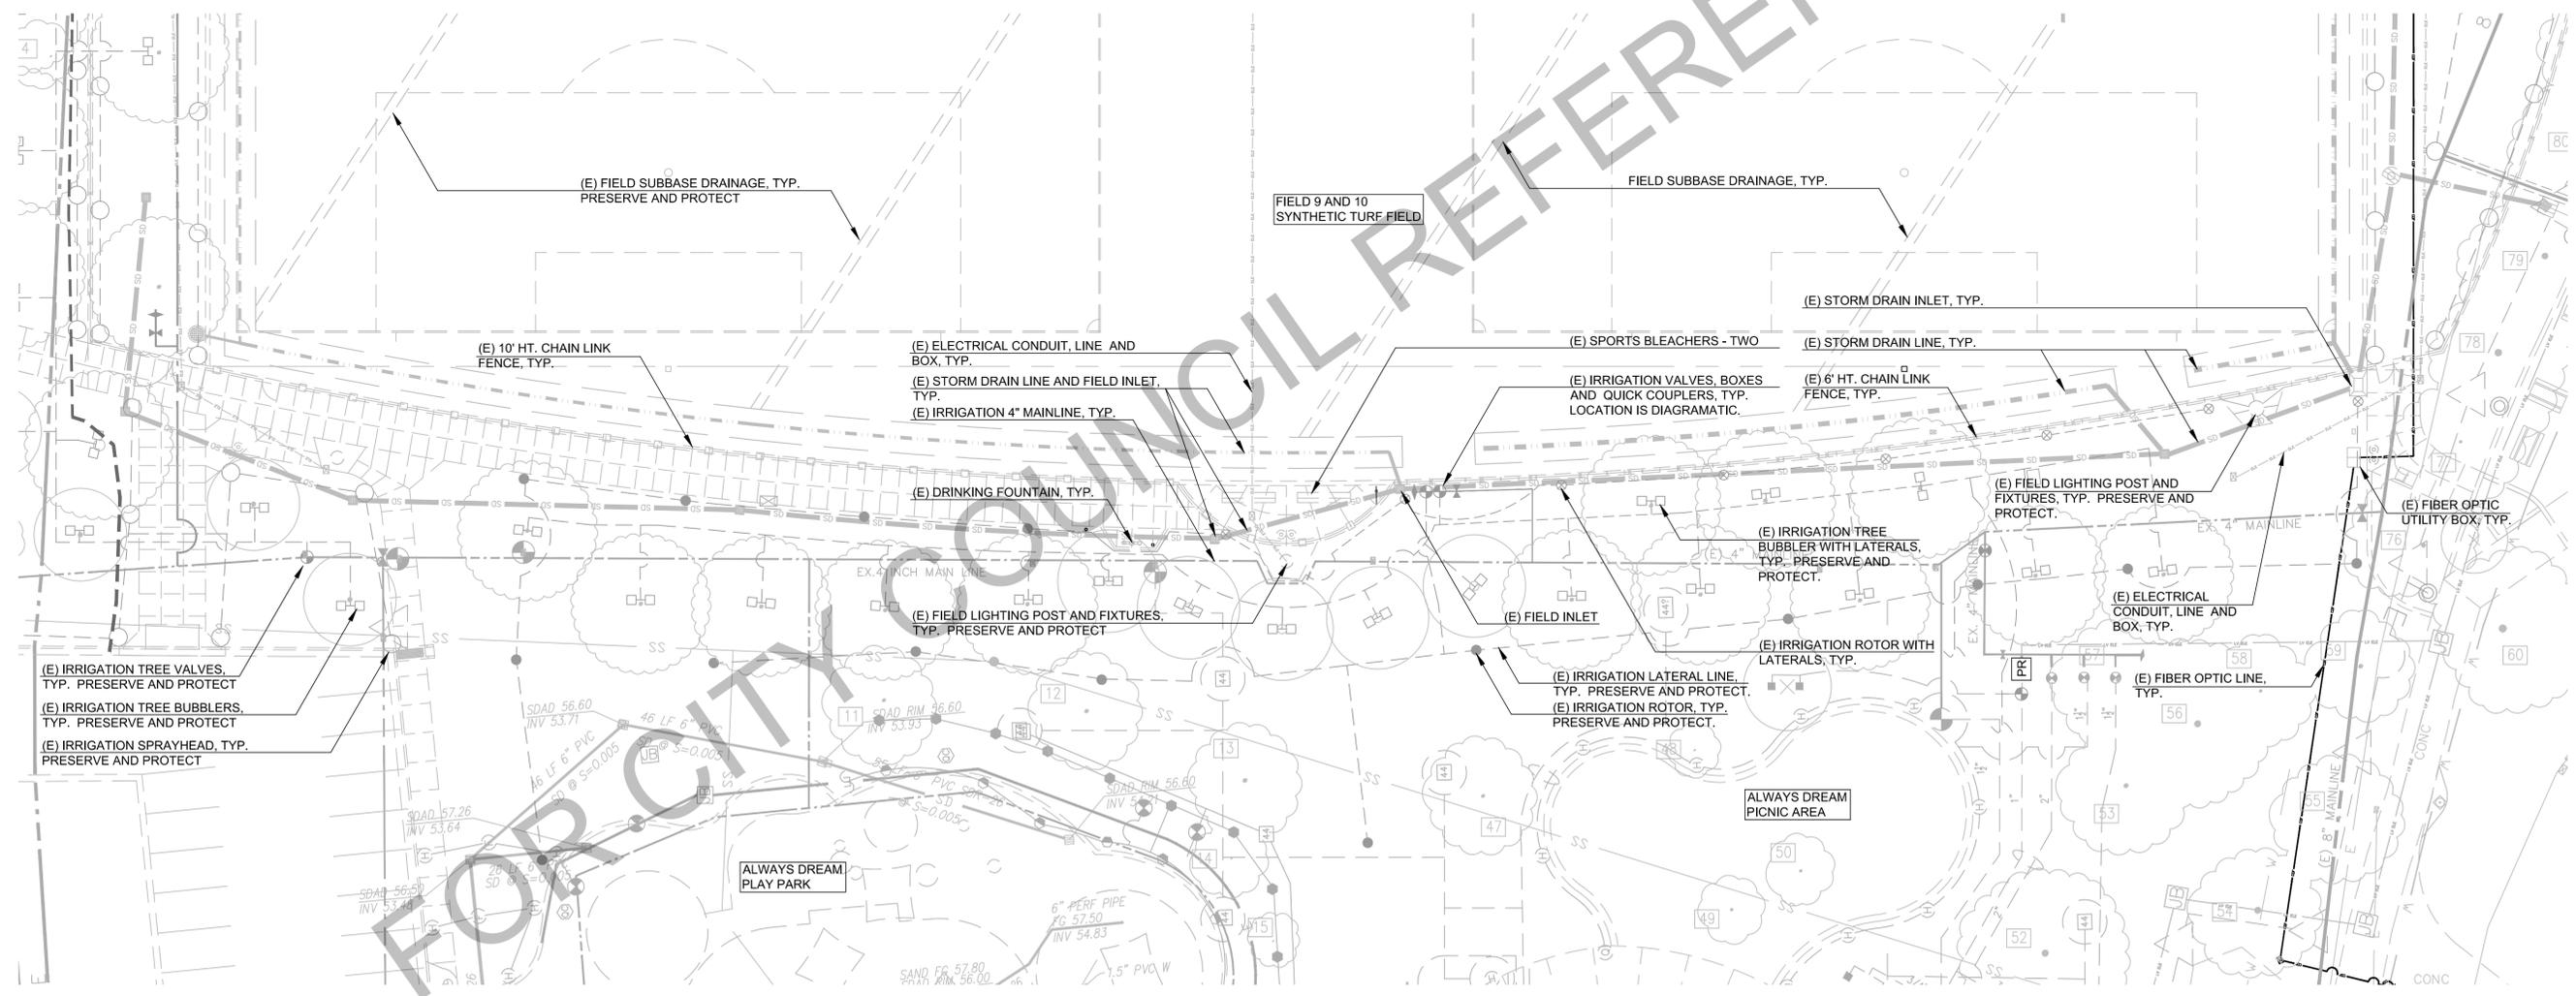

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No.	DATE	REVISION	BY	APPD
1	07/27/2018	BID SET		

**EXISTING UTILITY PLAN**

COMMUNITY SERVICES DEPARTMENT  
LANDSCAPE ARCHITECTURE DIVISION

APPROVED - SENIOR LANDSCAPE ARCHITECT: *[Signature]* DATE: 07/27/2018  
RECOMMENDED - PROJECT MANAGER: *[Signature]* DATE: 07/27/2018

SCALE: AS SHOWN  
CITY PROJECT: PWC 8878 B

DESIGNED BY: MM/JJS  
DRAWN BY: MM/JJS


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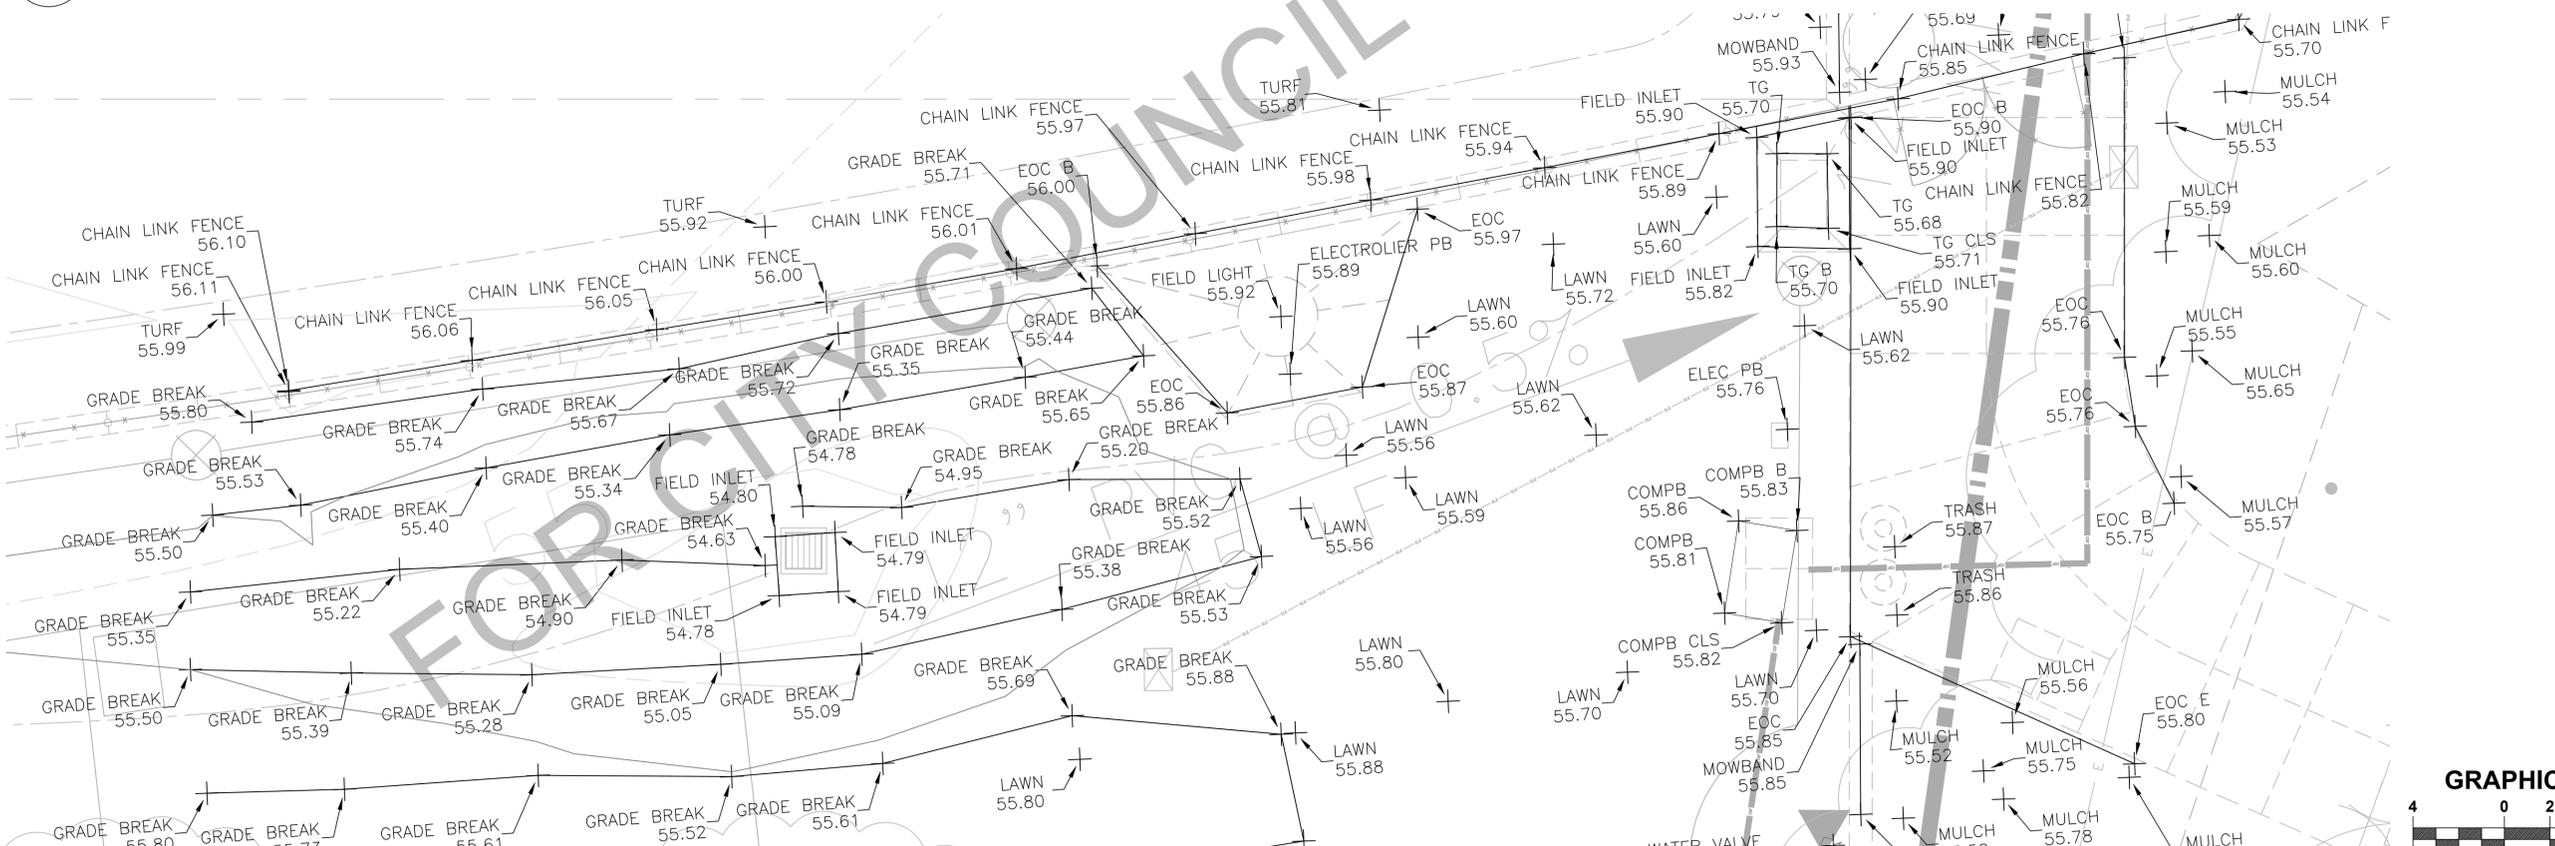
SHEET 3 OF 13




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**1** EXISTING GRADING PLAN -- ENLARGEMENT - NORTH



**2** EXISTING GRADING PLAN -- ENLARGEMENT - SOUTH

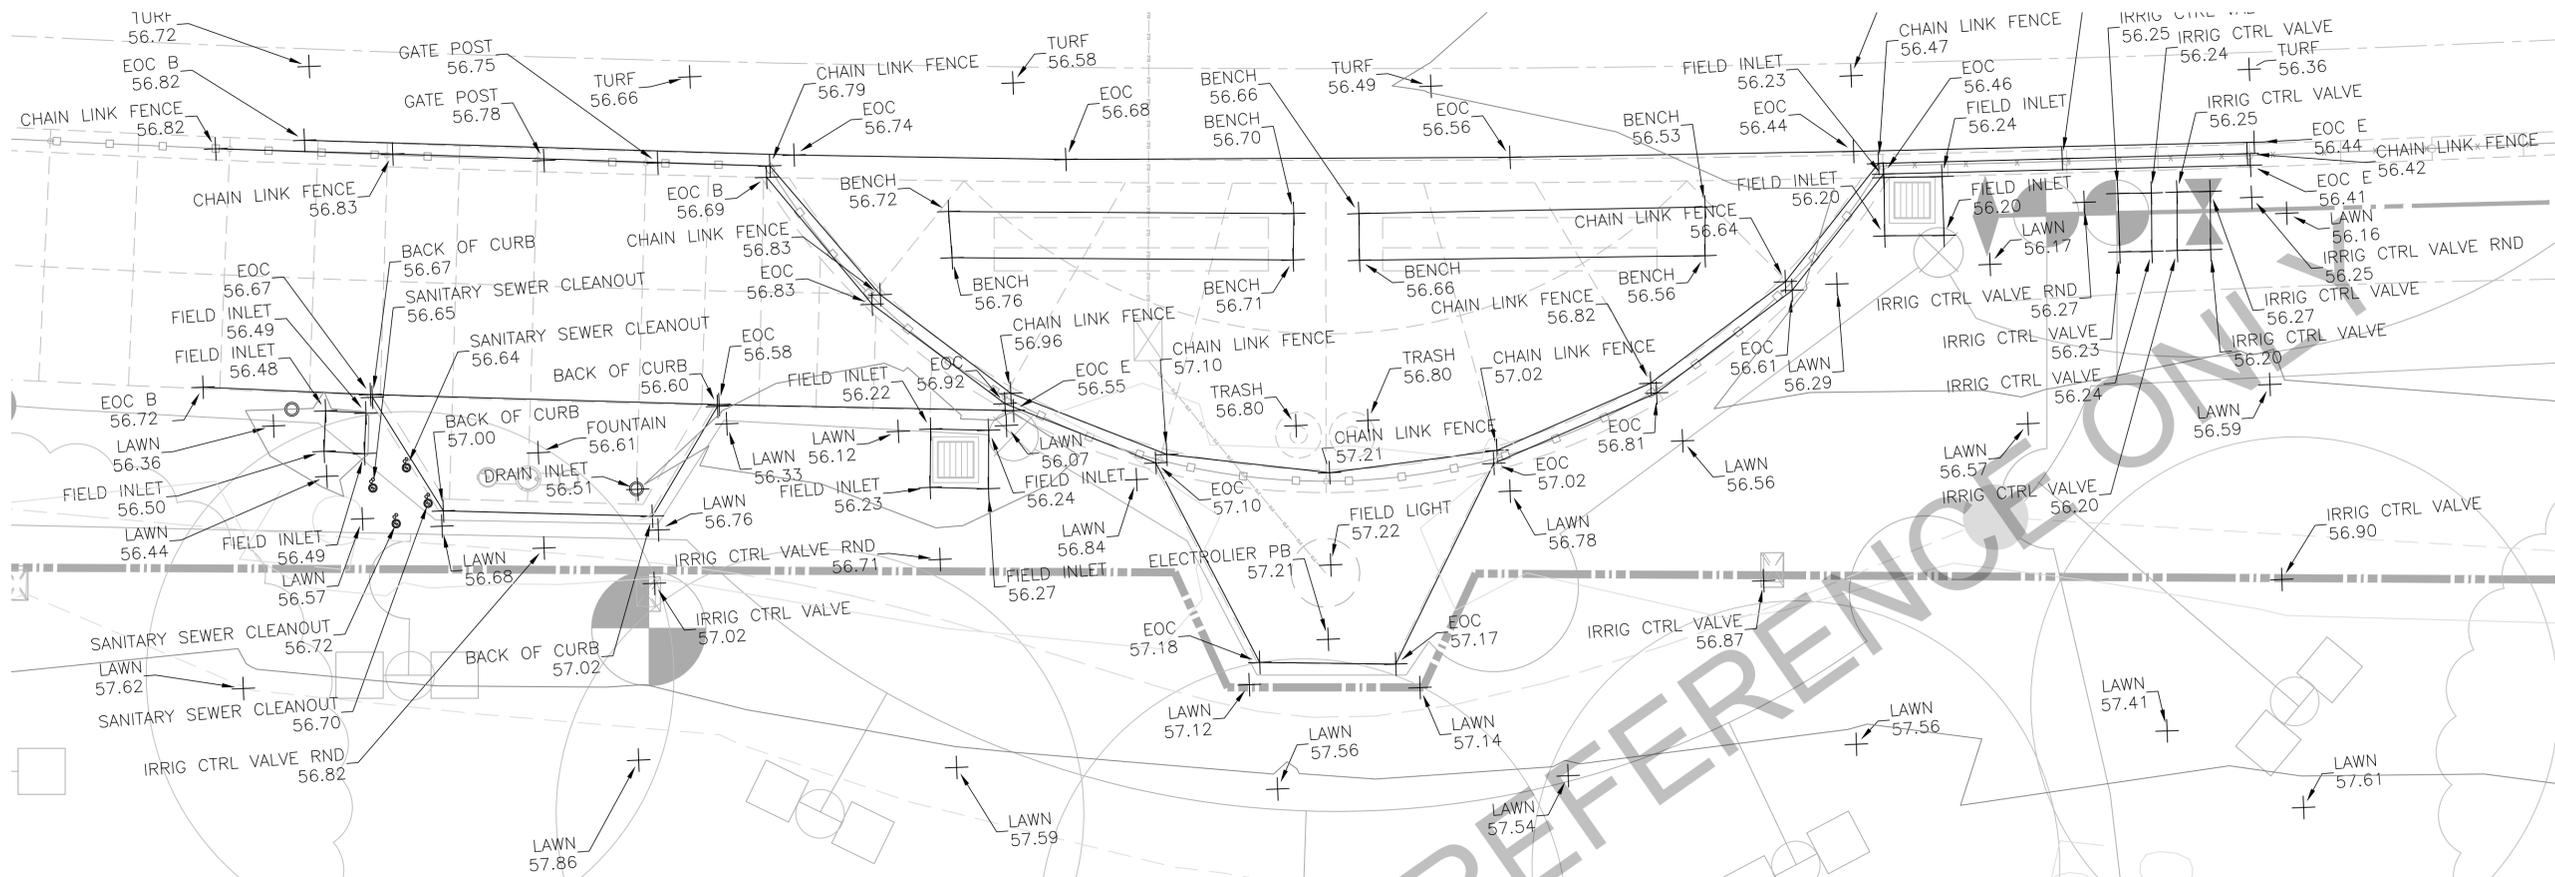

NOTE: VERIFY SCALE. BAR IS ONE INCH ON ORIGINAL DRAWING. ADJUST SCALES ACCORDINGLY IF BAR IS NOT ONE INCH. 0 1"

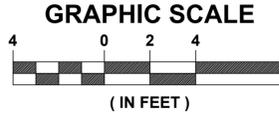BY	APPD		
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DATE	07/27/2018	BID SET	
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SCALE:	AS SHOWN	CITY PROJECT:	PWC 8878 B	DESIGNED BY:	MM/JJS	CHECKED BY:	MM/JJS	DATE:	07/2018
DRAWING:	<p><b>EXISTING GRADING PLAN</b></p> <p>COMMUNITY SERVICES DEPARTMENT LANDSCAPE ARCHITECTURE DIVISION</p> <p>APPROVED - SENIOR LANDSCAPE ARCHITECT: <i>[Signature]</i> RECOMMENDED - PROJECT MANAGER: <i>[Signature]</i></p>								


FIELDS 9 AND 10 FENCE EXTENSION

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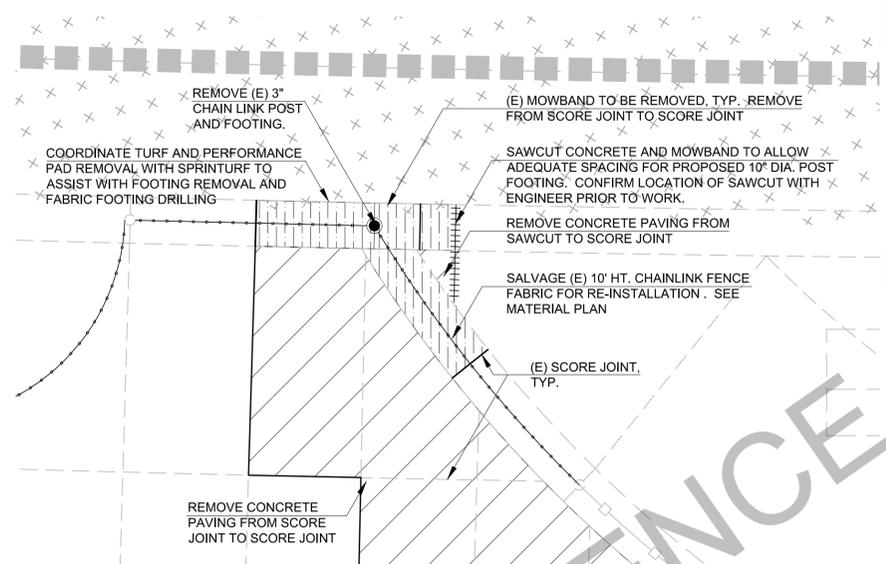
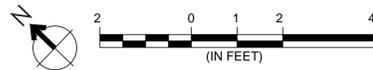
**L1.3**

SHEET 5 OF 13

PLOT DATE: Jul 27, 2018 - 8:50am FILE: T:\LANDARCH\PROJECT DIRECTORY\T\PCW8501 Fence Re-Alignment - Fields 9 & 10\DWG\Plan\Plan Set\8501\_DEMO.dwg

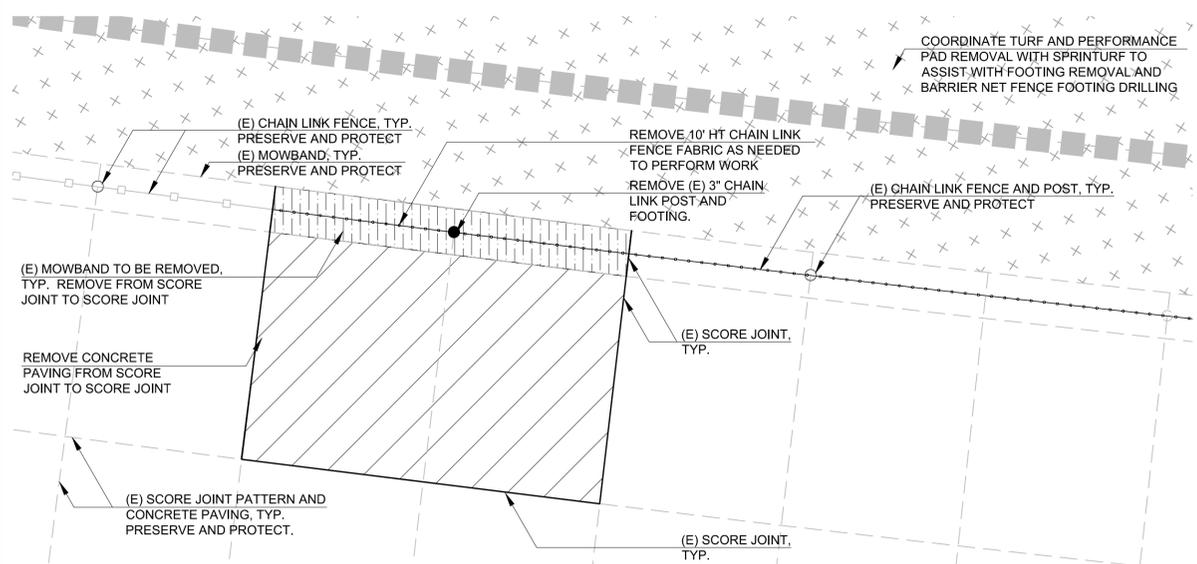

**1 (E) POST AND MOWBAND REMOVAL @ 10' HT CHAIN LINK FENCE**



**2 (E) POST AND MOWBAND REMOVAL @ BENCH - NORTH**




**DEMOLITION LEGEND:**


- SAW CUT, DEMOLISH AND REMOVE CONCRETE PAVING, TYP. FROM SCORE JOINT TO SCORE JOINT UNLESS OTHERWISE SPECIFIED.
- SAW CUT, DEMOLISH AND REMOVE MOWBAND JOINT TO JOINT, TYP.
- CLEAR, GRUB, DEMOLISH AND DISPOSE OF (E) TURF. PRESERVE AND PROTECT IRRIGATION LINES AND BOXES, IRRIGATION HEADS, UTILITY BOXES OR FIELD INLETS, TYP.
- (E) 10' HT CHAIN LINK FENCE AND FABRIC, PRESERVE AND PROTECT
- REMOVE AND REINSTALL (E) 10' HT CHAIN LINK FENCE AND FABRIC, AS NEEDED TO PERFORM WORK
- EXISTING CONCRETE PAVING TO REMAIN, TYP. PRESERVE AND PROTECT.
- EXISTING SYNTHETIC TURF AND INFILL WITH PERFORMANCE PAD, PRESERVE AND PROTECT. COORDINATE REMOVAL AND RE-INSTALLATION WITH MANUFACTURER.
- SALVAGE AND RE-USE IRRIGATION LINES AND ROTORS, TYP. RELOCATE TO EDGE OF PROPOSED CONCRETE PAVING TO ACHIEVE HEAD TO HEAD COVERAGE
- PROPOSED LOCATION OF SALVAGED IRRIGATION LATERAL AND HEADS, TYP. PROVIDE HEAD TO HEAD COVERAGE.

**DEMOLITION NOTES:**

- UNDERGROUND UTILITIES ARE SHOWN DIAGRAMMATICALLY. THE CONTRACTOR IS RESPONSIBLE FOR UNDERGROUND SERVICE ALERT (USA) AND POT HOLING. AS NEEDED, TO VERIFY LOCATIONS OF EXISTING UTILITIES. IF UTILITIES ARE ENCOUNTERED, THE CONTRACTOR SHALL IMMEDIATELY NOTIFY THE PROJECT INSPECTOR AND DETERMINE THE NEXT COURSE OF ACTION.
- ALL EXISTING STRUCTURES AND UTILITIES NOT CALLED OUT OR SLATED FOR DEMOLITION AND REMOVAL SHALL BE PRESERVED AND PROTECTED. IF DAMAGE OCCURS, REPLACEMENT SHALL BE THE RESPONSIBILITY OF THE CONTRACTOR AND SHALL BE REPLACEMENT IN KIND WITH APPROVAL BY ENGINEER.
- CONTRACTOR TO VERIFY LOCATION OF CHAIN LINK FENCE POST TO BE REMOVED IN THE FIELD. WHERE DISCREPANCIES ARISE, CONTACT ENGINEER FOR RESOLUTION.
- UNLESS OTHERWISE SHOWN, EXISTING CONCRETE SURFACE TO REMAIN. PRESERVE AND PROTECT. IF DAMAGE OCCURS, REPLACEMENT SHALL BE THE RESPONSIBILITY OF THE CONTRACTOR AND SHALL BE REPLACEMENT IN KIND WITH APPROVAL BY ENGINEER.
- SYNTHETIC TURF SHALL BE PROTECTED SUCH A WAY THAT IT DOES NOT VOID THE WARRANTY OF THE TURF OR PERFORMANCE LAYER UNDERNEATH. AT MINIMUM, PROTECTION TO BE HEAVY DUTY PLYWOOD OR OTHER MATERIAL AND PROTECTION MEASURE MUST BE APPROVED IN WRITING BY SYNTHETIC TURF MANUFACTURER PRIOR TO USE. FOR ADDITIONAL INFORMATION REFER TO SPECIFICATIONS.

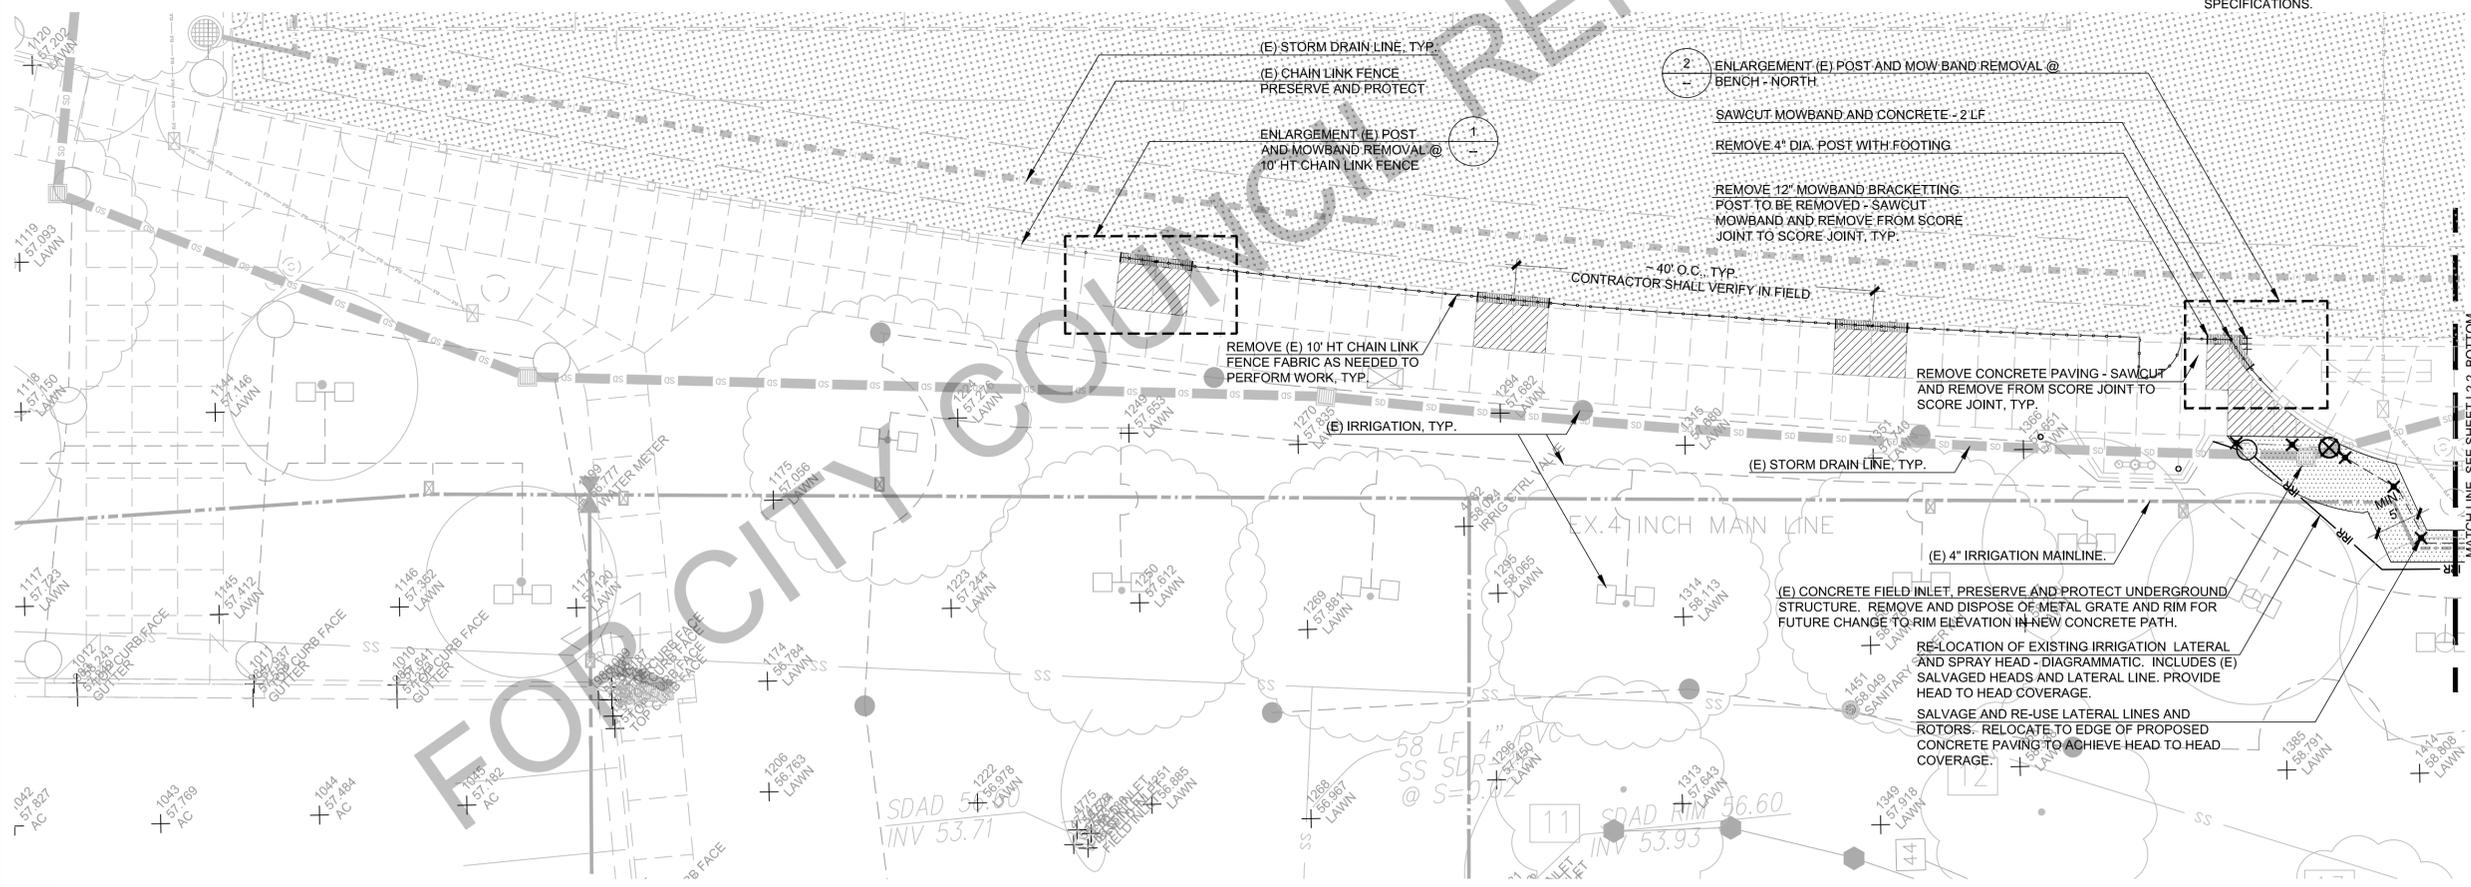


**3 FIELD 9 AND 10 DEMOLITION PLAN - NORTH**

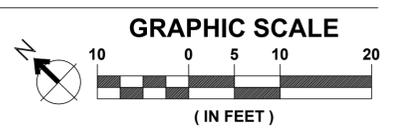

NOTE: VERIFY SCALE. BAR IS ONE INCH ON ORIGINAL DRAWING. ADJUST SCALES ACCORDINGLY IF BAR IS NOT ONE INCH. 0 1"

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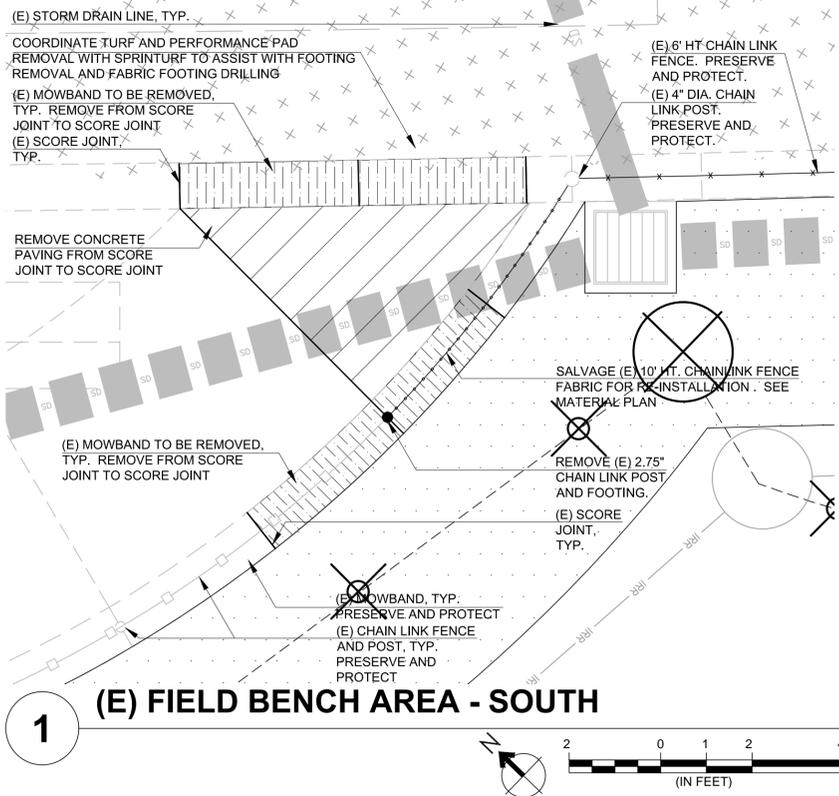
**DEMOLITION PLAN**

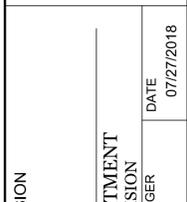COMMUNITY SERVICES DEPARTMENT  
LANDSCAPE ARCHITECTURE DIVISION


APPROVED - SENIOR LANDSCAPE ARCHITECT DATE 07/27/2018  
RECOMMENDED - PROJECT MANAGER DATE 07/27/2018

SCALE:	AS SHOWN
CITY PROJECT:	PWC 8878 B
DESIGNED BY:	MM/JJS
CHECKED BY:	MM/JJS
DRAWN BY:	MM/JJS
DATE:	07/2018


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**1 (E) FIELD BENCH AREA - SOUTH**




**2 (E) POST AND MOWBAND REMOVAL @ 6' HT CHAIN LINK FENCE**

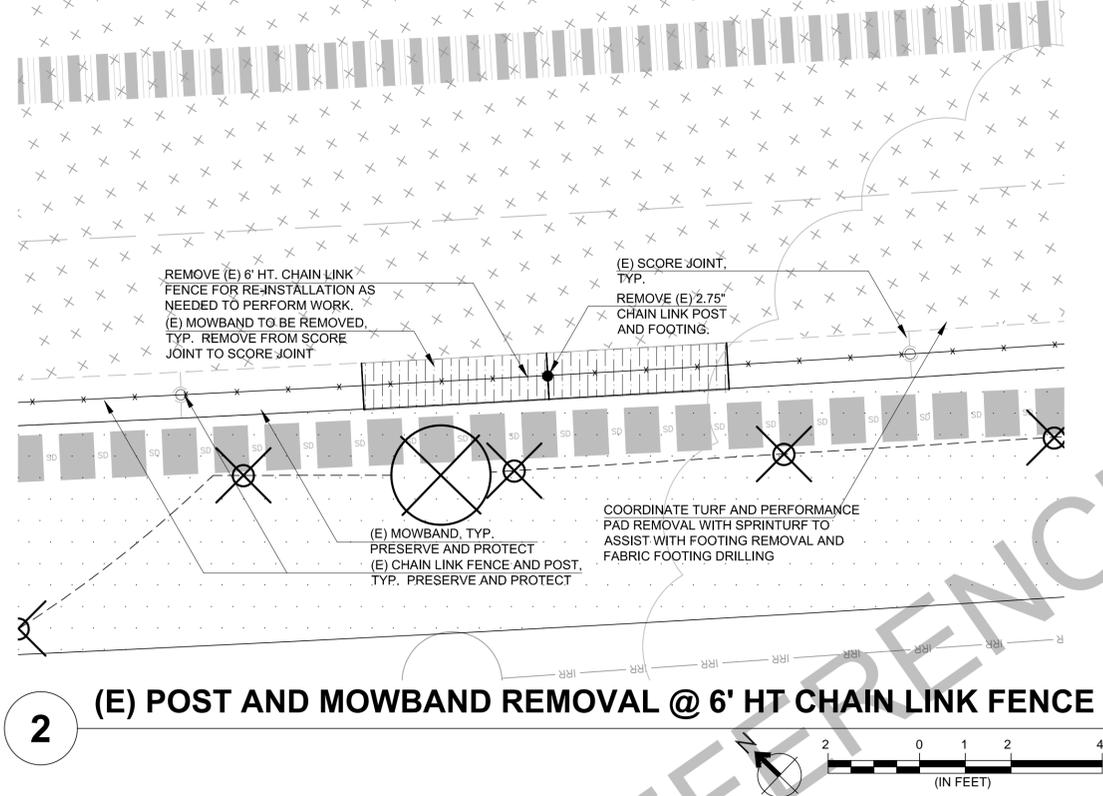


**DEMOLITION LEGEND:**

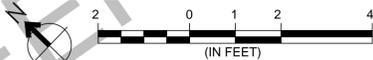	SAW CUT, DEMOLISH AND REMOVE CONCRETE PAVING, TYP. FROM SCORE JOINT TO SCORE JOINT UNLESS OTHERWISE SPECIFIED.
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	(E) 6' HT CHAIN LINK FENCE AND FABRIC, PRESERVE AND PROTECT
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	(E) 10' HT CHAIN LINK FENCE AND FABRIC, PRESERVE AND PROTECT
	REMOVE AND REINSTALL (E) 10' HT CHAIN LINK FENCE AND FABRIC, AS NEEDED TO PERFORM WORK
	EXISTING CONCRETE PAVING TO REMAIN, TYP. PRESERVE AND PROTECT.
	EXISTING SYNTHETIC TURF AND INFILL, PRESERVE AND PROTECT. COORDINATE REMOVAL AND RE-INSTALLATION WITH MANUFACTURER.
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  - CONTRACTOR TO VERIFY LOCATION OF CHAIN LINK FENCE POST TO BE REMOVED IN THE FIELD. WHERE DISCREPANCIES ARISE, CONTACT ENGINEER FOR RESOLUTION.
  - UNLESS OTHERWISE SHOWN, EXISTING CONCRETE SURFACE TO REMAIN. PRESERVE AND PROTECT. IF DAMAGE OCCURS, REPLACEMENT SHALL BE THE RESPONSIBILITY OF THE CONTRACTOR AND SHALL BE REPLACEMENT IN KIND WITH APPROVAL BY ENGINEER.
  - SYNTHETIC TURF SHALL BE PROTECTED SUCH A WAY THAT IT DOES NOT VOID THE WARRANTY OF THE TURF OR PERFORMANCE LAYER UNDERNEATH. AT MINIMUM, PROTECTION TO BE HEAVY DUTY PLYWOOD OR OTHER MATERIAL AND PROTECTION MEASURE MUST BE APPROVED IN WRITING BY SYNTHETIC TURF MANUFACTURER PRIOR TO USE. FOR ADDITIONAL INFORMATION REFER TO SPECIFICATIONS.

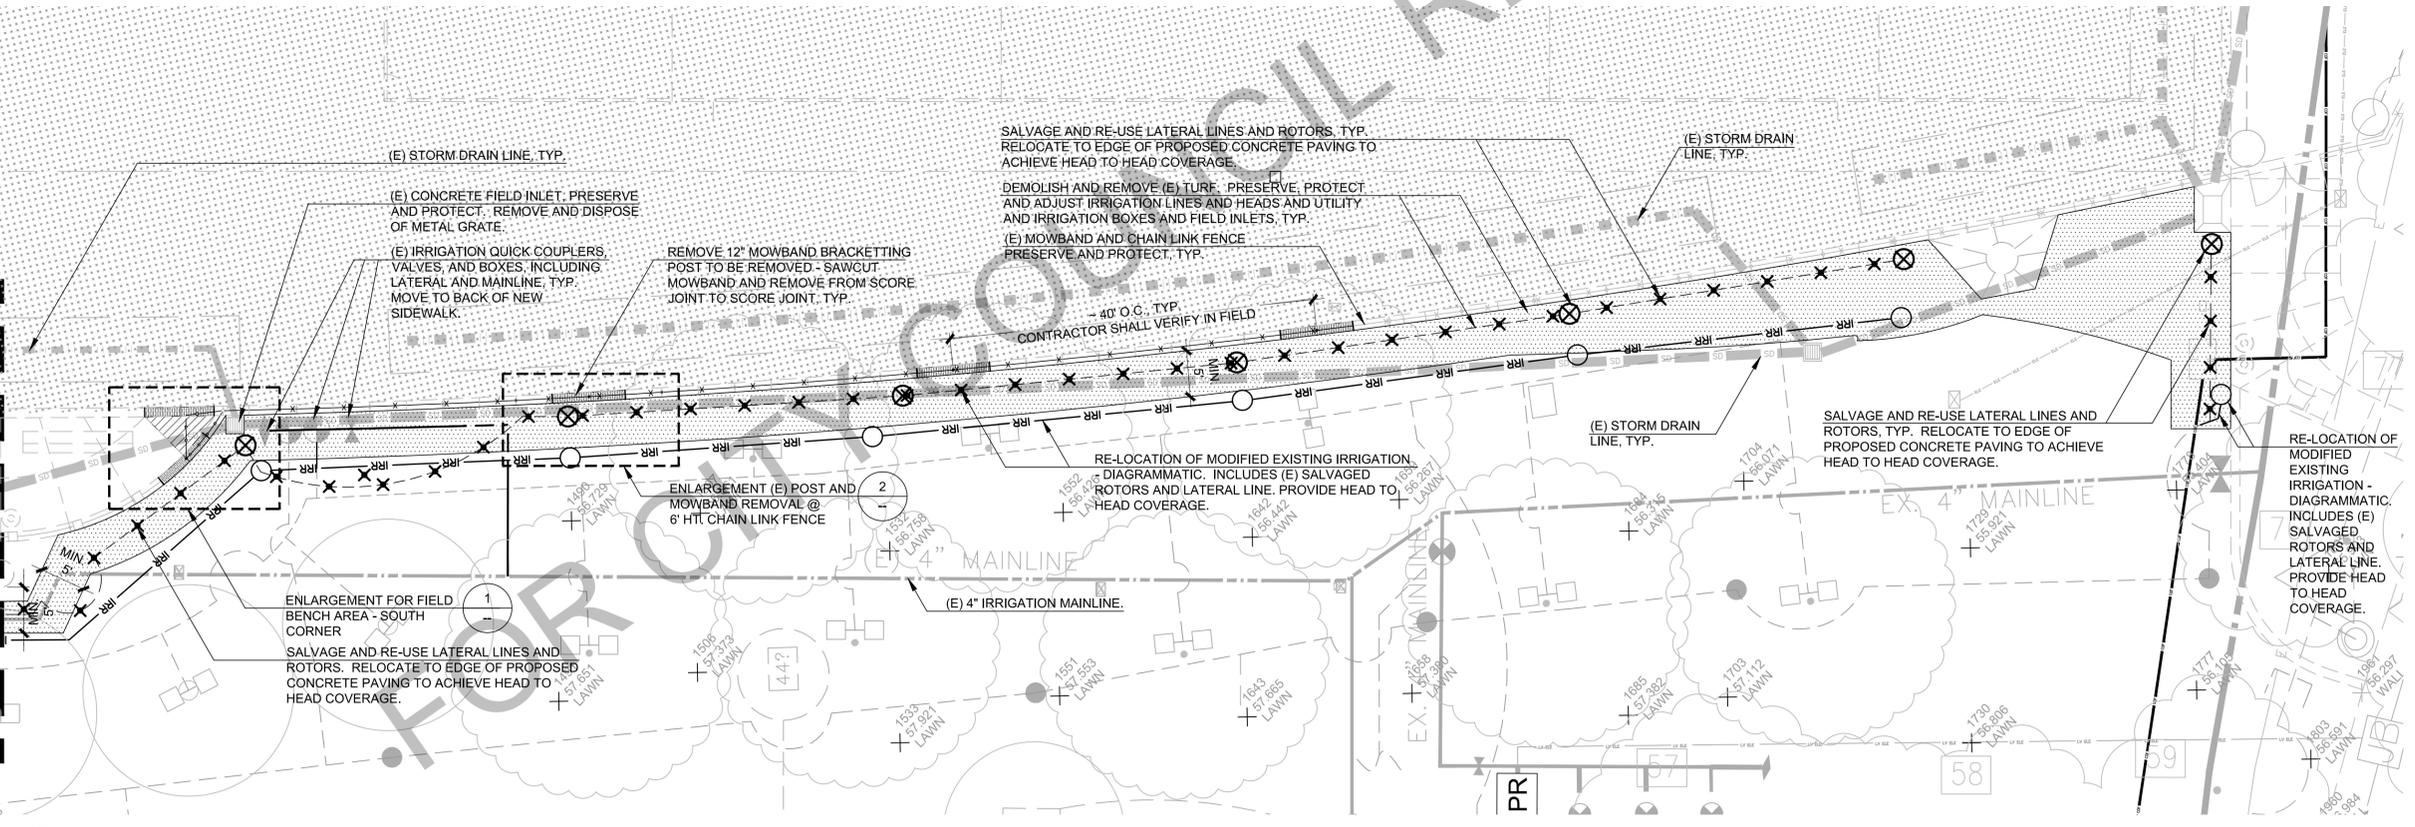


**3 FIELD 9 AND 10 DEMOLITION PLAN - SOUTH**

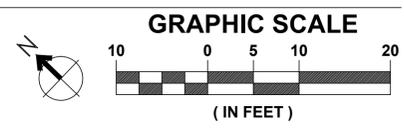


SCALE: AS SHOWN	CITY PROJECT: PWC 8878 B	DESIGNED BY: MIM/JJS	CHECKED BY: MIM/JJS	DRAWN BY: MIM/JJS	DATE: 07/2018
DRAWING: <b>L2.2</b>					
NOTE: VERIFY SCALE. BAR IS ONE INCH ON ORIGINAL DRAWING. ADJUST SCALES ACCORDINGLY IF BAR IS NOT ONE INCH. 0 1"					
SHEET 7 OF 13					
<p>APPROVED - SENIOR LANDSCAPE ARCHITECT</p> <p>RECOMMENDED - PROJECT MANAGER</p> <p>DATE: 07/27/2018</p>					
<p>COMMUNITY SERVICES DEPARTMENT</p> <p>LANDSCAPE ARCHITECTURE DIVISION</p> <p>DATE: 07/27/2018</p>					
<p>DEMOLITION PLAN</p> <p>FIELDS 9 AND 10 FENCE EXTENSION</p>					
<p>BY: APPD</p> <p>REVISION: BID SET</p> <p>DATE: 07/27/2018</p>					


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**1 GRADING PLAN, ENLARGEMENT - NORTH**

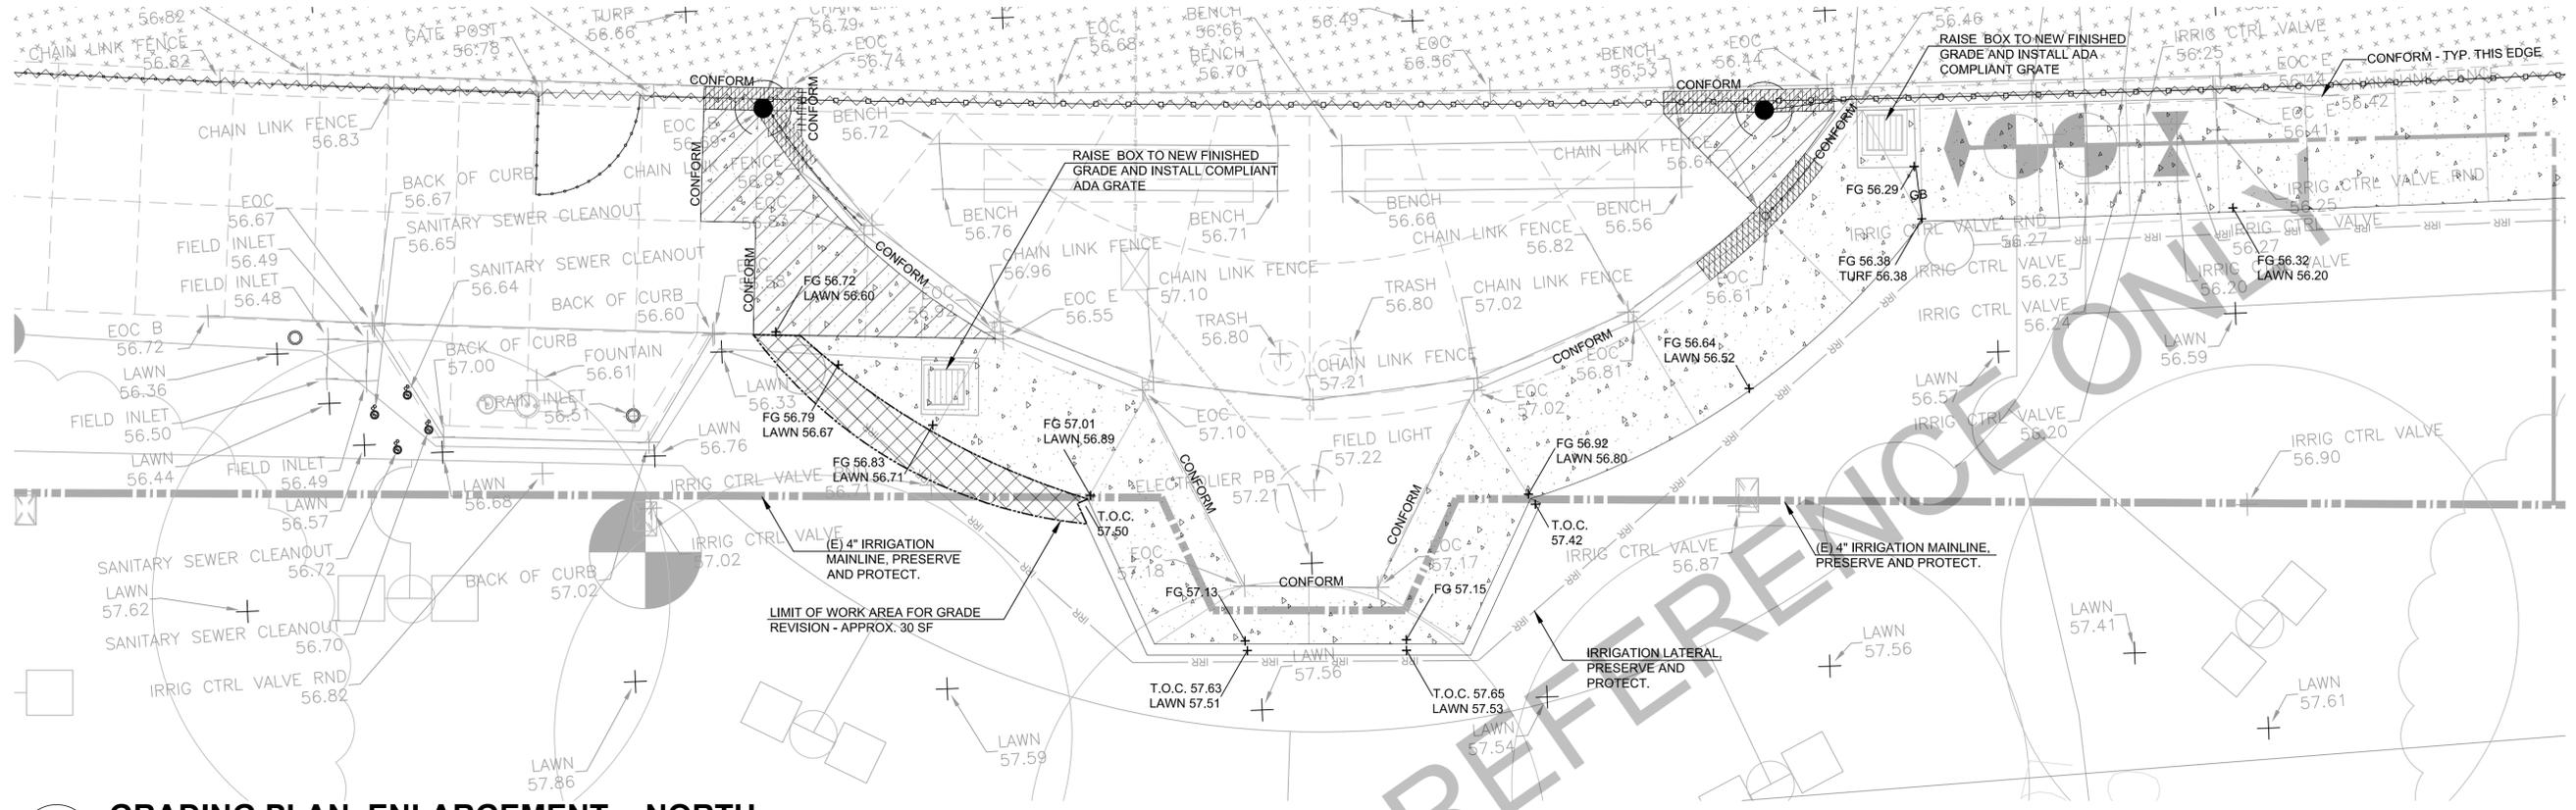


**2 GRADING PLAN, ENLARGEMENT - SOUTH**

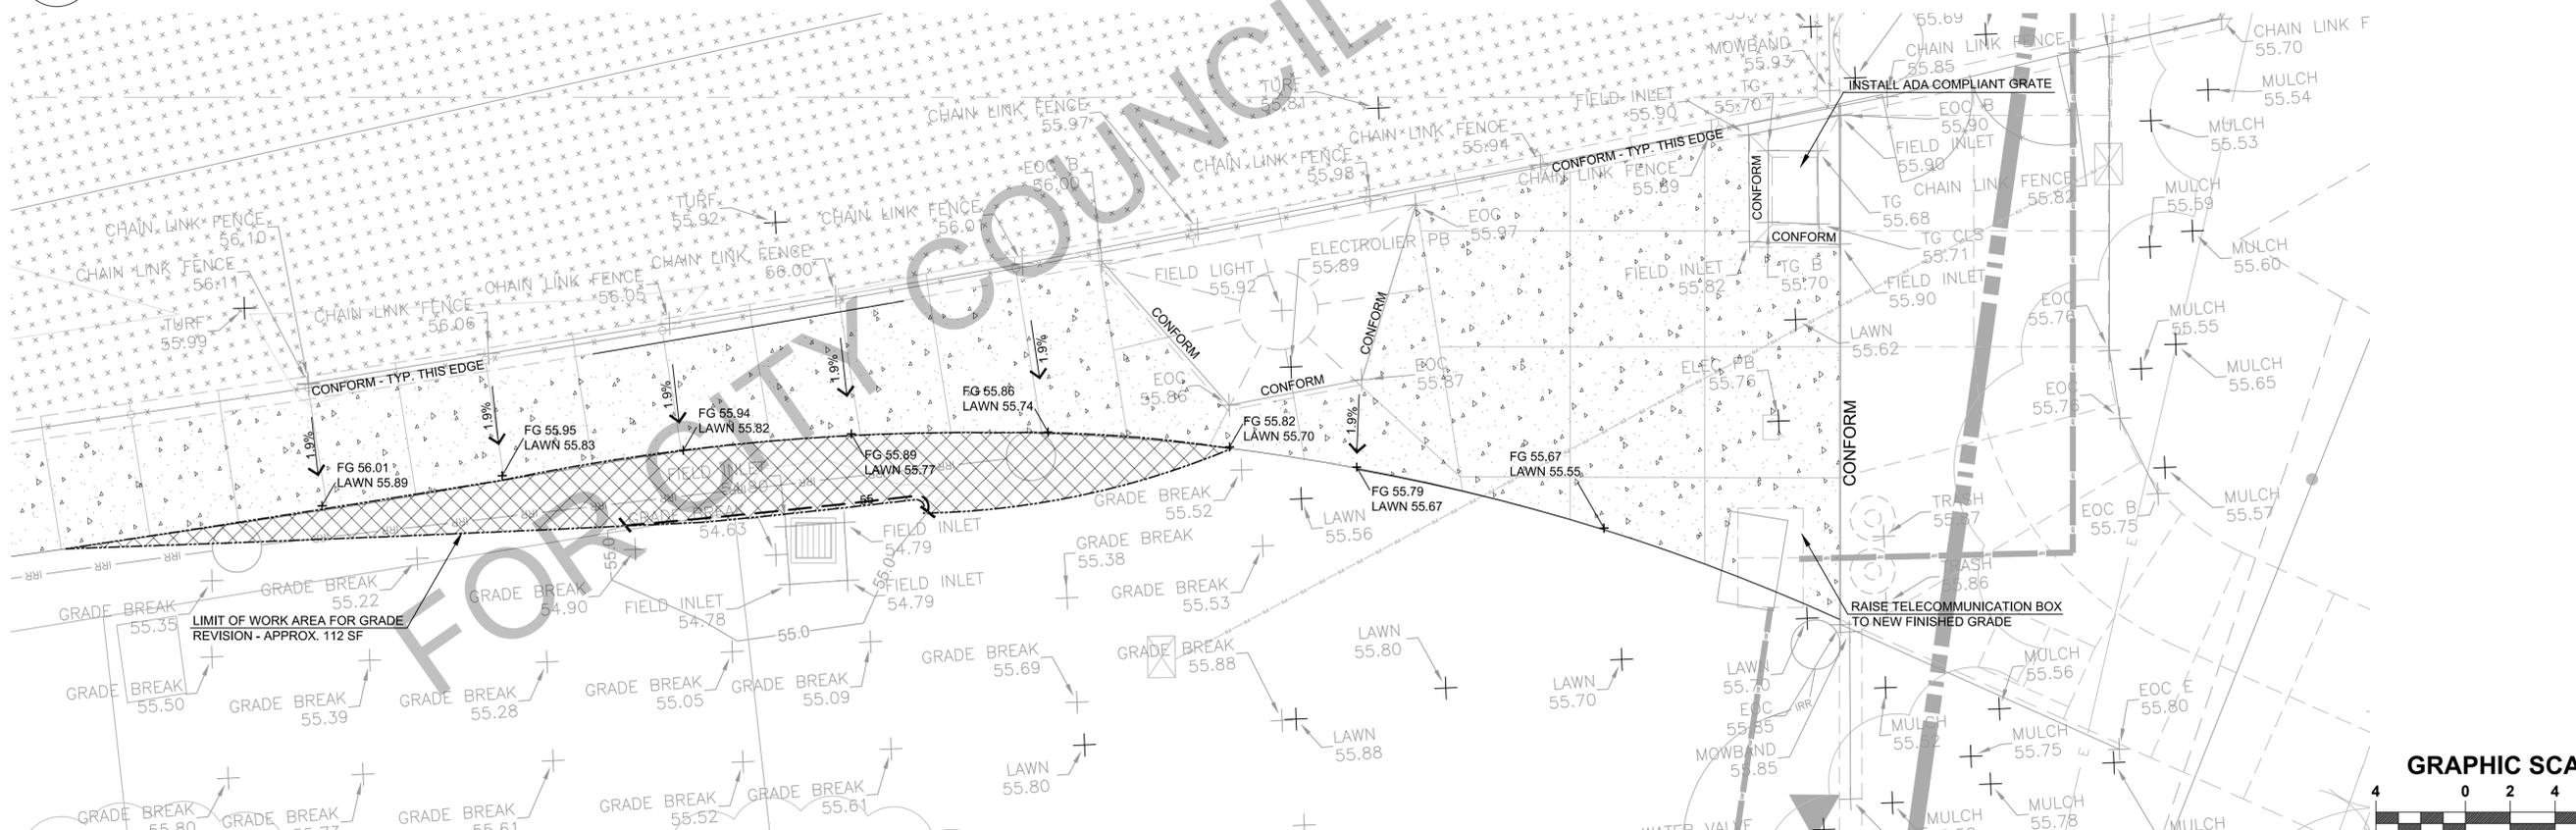

NOTE: VERIFY SCALE. BAR IS ONE INCH ON ORIGINAL DRAWING. ADJUST SCALES ACCORDINGLY IF BAR IS NOT ONE INCH.

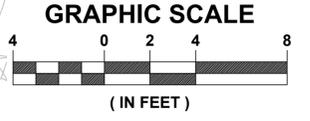BY	APPD
REVISION	
DATE	07/27/2018
BID SET	
No	

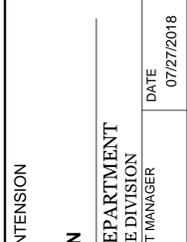

FIELDS 9 AND 10 FENCE EXTENSION

**GRADING PLAN**

COMMUNITY SERVICES DEPARTMENT  
LANDSCAPE ARCHITECTURE DIVISION

APPROVED - SENIOR LANDSCAPE ARCHITECT  
RECOMMENDED - PROJECT MANAGER

DATE: 07/27/2018


SCALE:	AS SHOWN
CITY PROJECT:	PWC 8878 B
DESIGNED BY:	MM/JJS
CHECKED BY:	MM/JJS
DRAWN BY:	MM/JJS
DATE:	07/2018
DRAWING:	








- NOTES**
1. CONCRETE TO BE 6 SACK MIX, DARKENED WITH LAMP BLACK, 1 POUND PER CUBIC YARD
  2. TOP OF MOW BAND TO BE FLUSH WITH ANY ADJACENT PAVING
  3. PROVIDE DEEP JOINTS 10' O.C., AND SCORE JOINTS 5' O.C. MAXIMUM EXPANSION JOINT NOT REQUIRED. ALIGN WITH NEAREST ADJACENT PAVEMENT JOINTS WHERE POSSIBLE.
  4. CONCRETE FINISH: MEDIUM BROOM FINISH PERPENDICULAR TO LENGTH OF MOW BAND
  5. REFER TO DETAIL NOTES.

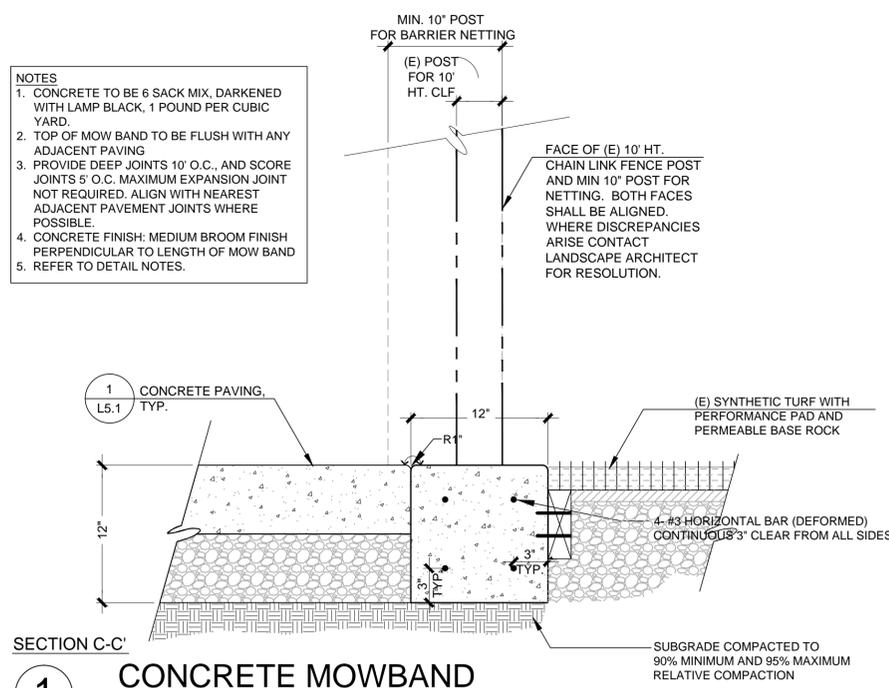


**1 CONCRETE MOWBAND**  
SCALE: 1-1/2" = 1'-0"

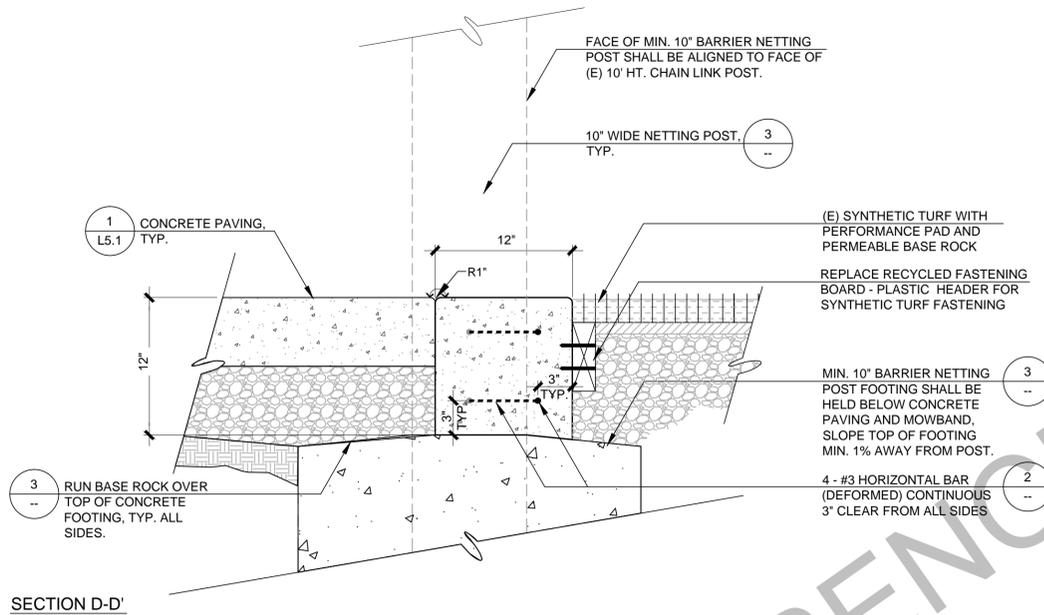


**3 10" DIA. POST FOOTING**  
SCALE: 1/2" = 1'-0"


- DETAIL NOTES:**
- 1) CONTRACTOR SHALL COORDINATE ALL WORK INVOLVING THE SYNTHETIC TURF AND PERFORMANCE LAYER WITH MANUFACTURER, SPRINTURF. REFER TO SPECIFICATIONS FOR ADDITIONAL INFORMATION AND REQUIREMENTS.
  - 2) SYNTHETIC TURF SHALL BE PROTECTED SUCH A WAY THAT IT DOES NOT VOID THE WARRANTY OF THE TURF OR PERFORMANCE LAYER UNDERNEATH. AT MINIMUM, PROTECTION TO BE HEAVY DUTY PLYWOOD OR OTHER MATERIAL AND PROTECTION MEASURE MUST BE APPROVED IN WRITING BY SYNTHETIC TURF MANUFACTURER PRIOR TO USE. FOR ADDITIONAL INFORMATION REFER TO SPECIFICATIONS.
  - 3) DETAIL FOR NETTING AND POST IS FOR REFERENCE ONLY. 40' BARRIER NETTING FENCE IS DESIGN BUILD. CONTRACTOR SHALL PROVIDE SHOP DRAWINGS AND CALIFORNIA ENGINEER STAMPED STRUCTURAL CALCULATIONS FOR BUILDING PERMIT AND REVIEW AND APPROVAL. BARRIER NETTING AND POST SHALL MEET 110 MPH WINDS, EXPOSURE 'C' STRENGTH DESIGN PER ASCE 7-10 - 2015 INTERNATIONAL BUILDING CODE, 2016 CALIFORNIA BUILDING CODE AND SEISMIC ZONE REQUIREMENTS.

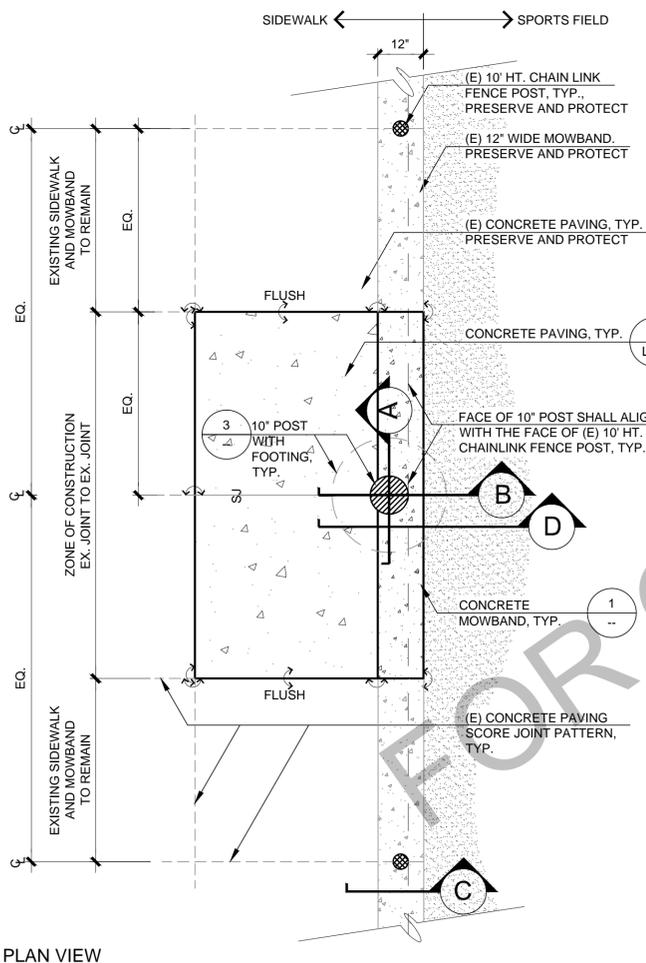

**2 MOWBAND WITH FENCE POST - PLAN VIEW**  
SCALE: 1/2" = 1'-0"

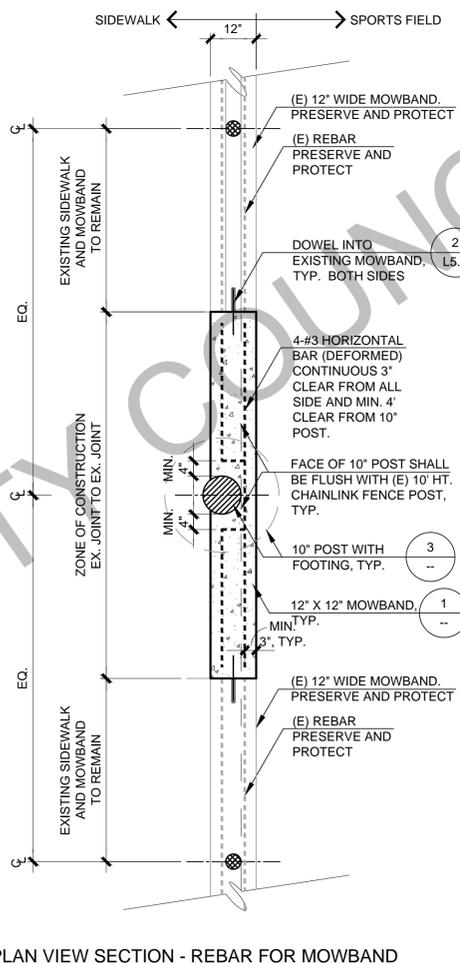

PLAN VIEW SECTION - REBAR FOR MOWBAND

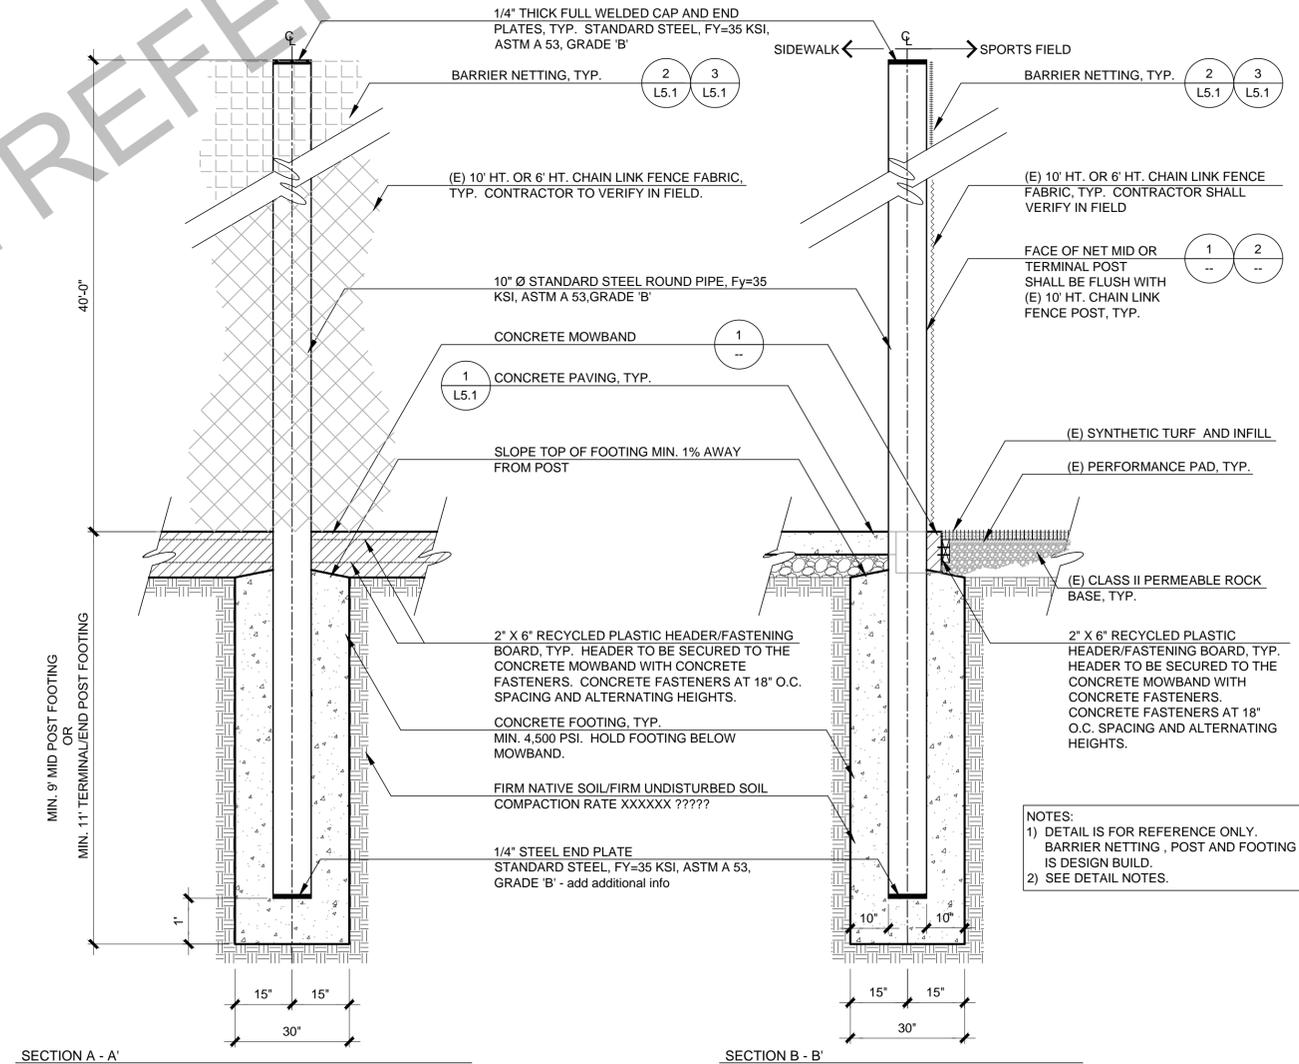

**3 10" DIA. POST FOOTING**  
SCALE: 1/2" = 1'-0"

- NOTES:**
- 1) DETAIL IS FOR REFERENCE ONLY. BARRIER NETTING, POST AND FOOTING IS DESIGN BUILD.
  - 2) SEE DETAIL NOTES.

PLOT DATE: Jul 27, 2018 - 8:51am FILE: T:\LANDARCH\PROJECT DIRECTORY\T\PWC8501 Fence Re-alignment - Fields 9 & 10\DWG\Plan\Plan Set\B501\_DETAILS.dwg

APPD	
BY	
REVISION	
BID SET	
DATE	07/27/2018
No.	1



DATE 07/27/2018

**CONSTRUCTION DETAILS**  
COMMUNITY SERVICES DEPARTMENT  
LANDSCAPE ARCHITECTURE DIVISION  
RECOMMENDED - PROJECT MANAGER

DATE 07/27/2018

**Fremont**  
CITY OF  
APPROVED - SENIOR LANDSCAPE ARCHITECT

SCALE: AS SHOWN  
CITY PROJECT: PWC 8878 B  
DESIGNED BY: MM/JJS  
DRAWN BY: MM/JJS  
DATE: 07/20/18

DRAWING:  
**L5.2**  
SHEET 12 OF 13

NOTE: VERIFY SCALE. BAR IS ONE INCH ON ORIGINAL DRAWING. ADJUST SCALES ACCORDINGLY IF BAR IS NOT ONE INCH. 0 +-----+ 1'

